

NOTE: REFER TO

WINDOW HEAD: SSETB-DP2SU032

WINDOW JAMB: SSETB-DP2SU042-44

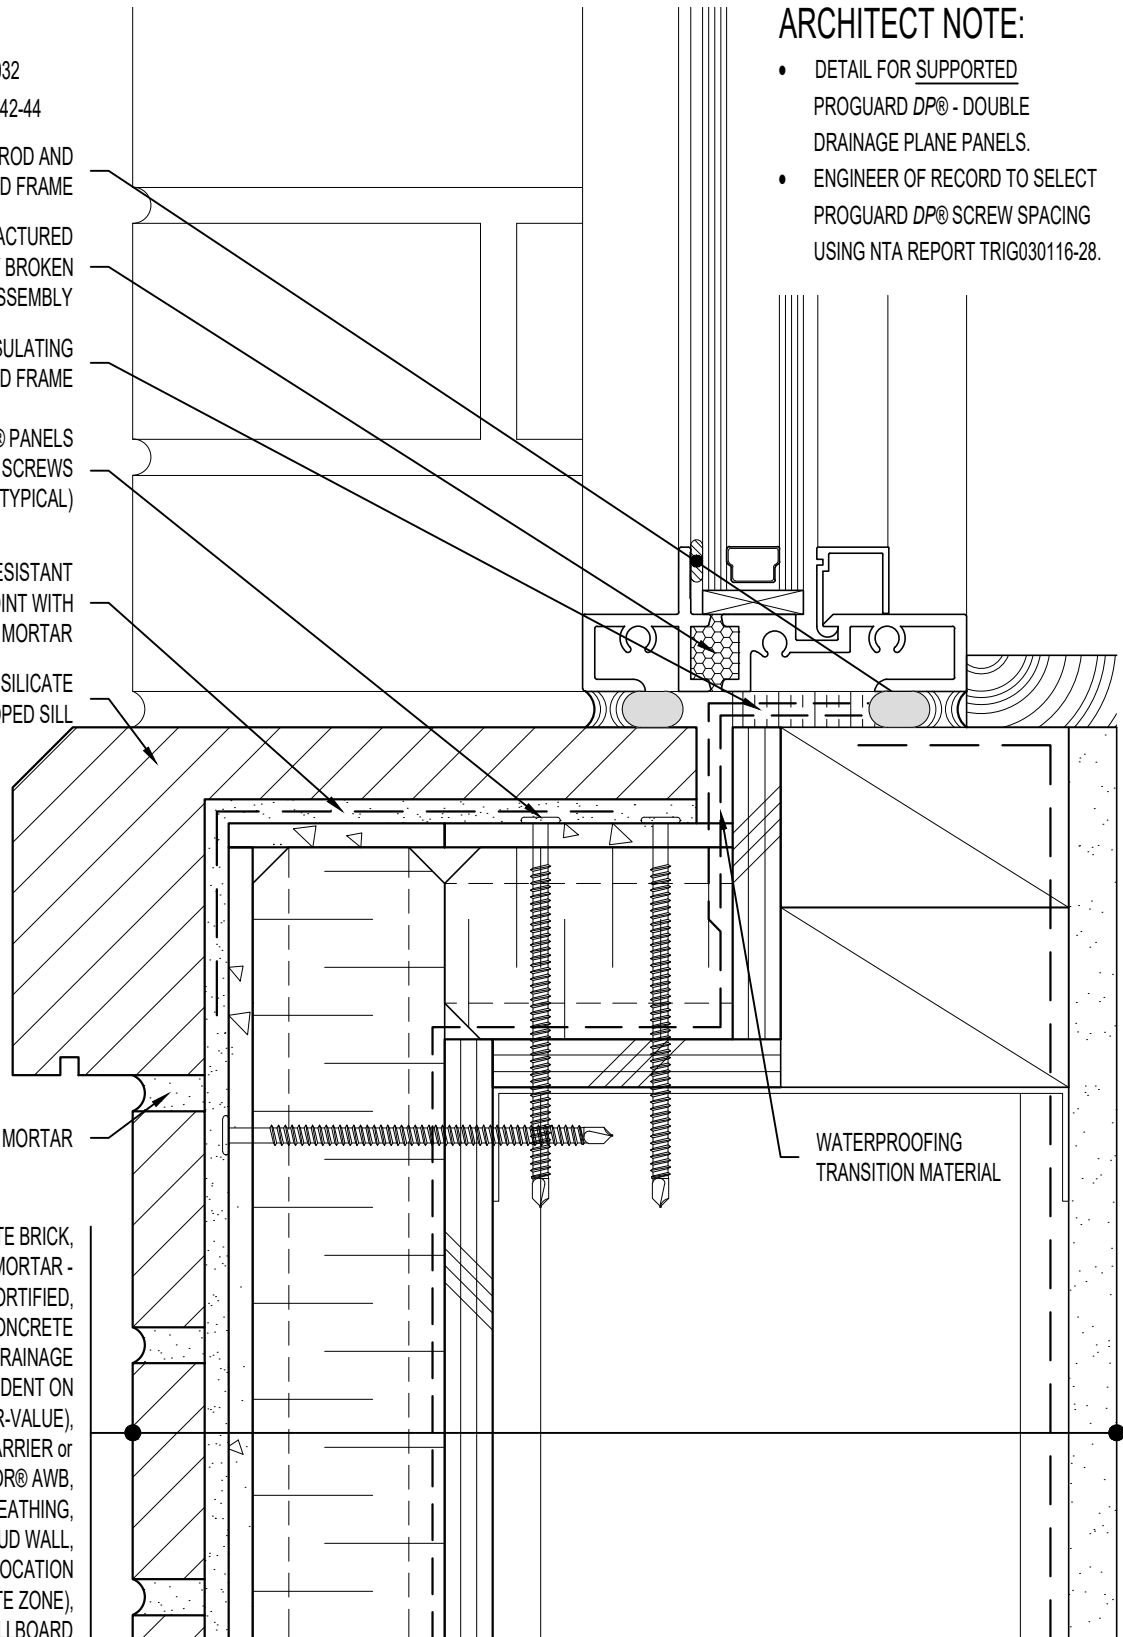
COMPRESSIBLE BACKER ROD AND
SILICONE SEALANT AROUND FRAMEPREMANUFACTURED
THERMALLY BROKEN
ALUMINUM WINDOW ASSEMBLYSPRAY APPLIED FOAM INSULATING
AIR SEAL AROUND FRAMEATTACH PROGUARD DP® PANELS
WITH SILVER C APPROVED SCREWS
THROUGH TO STUDS (TYPICAL)TAPE JOINT WITH ALKALI-RESISTANT
MESH TAPE AND MUD JOINT WITH
MVIS™ THIN BRICK MORTARCALCIUM SILICATE
SLOPED SILL

MVIS™ POINTING MORTAR

THIN-CLAD CALCIUM SILICATE BRICK,
MVIS™ THIN BRICK MORTAR -
POLYMER FORTIFIED,
PROGUARD DP® INSULATED CONCRETE
BOARD PANEL - DOUBLE DRAINAGE
PLANE (THICKNESS DEPENDENT ON
REQUIRED R-VALUE),
MVIS™ AIR & WATER BARRIER or
WATERARMOR® AWB,
EXTERIOR SHEATHING,
STEEL STUD WALL,
VAPOR BARRIER (LOCATION
DEPENDENT ON CLIMATE ZONE),
GYPSUM WALLBOARD

ARCHITECT NOTE:

- DETAIL FOR SUPPORTED
PROGUARD DP® - DOUBLE
DRAINAGE PLANE PANELS.
- ENGINEER OF RECORD TO SELECT
PROGUARD DP® SCREW SPACING
USING NTA REPORT TRIG030116-28.

**ARRISCRAFT·CADD**

TITLE:

SLOPED WINDOW SILL - DEEP
RECESSED WINDOW

DETAIL No:

SSETB - DP2S

U028

DATE DRAWN:

02 Mar 2022

SCALE:

1-1/2"=1'-0"

DRAWN BY:

TRI